Habitat for Humanity

Custom Residence

Lot 5 Pike Ave Attleboro, MA 02703



IECC TABLE 402.1.2 II REQUIREME	nsulation and fe nts by componen							
ASSEMBLY	ASSEMBLY REQUIREMENT ACTUAL							
WOOD FRAME CAVITY WALL ¹	R=20	R=21						
WOOD FRAME FLOOR ¹	R=30	R=30						
WOOD FRAME CEILING 1 2 3	R=49	R=49						
WINDOWS	U=0.300	U≤ 0.300						
DOORS	U=0.300	U≤ 0.300						
BASEMENT WALLS	15/19 4	15/19 ⁴						



1 R503.1.1 BUILDING ENVELOPE EXCEPTION 2:

THE FOLLOWING ALTERATIONS NEED NOT COMPLY WITH THE REQUIREMNTS FOR NEW CONSTRUCTION PROVIDED THE ENERGY USE OF THE BUILDING IS NOT INCREASED: EXISTING CEILING, WALL OR FLOOR CAVITIES EXPOSED DURING CONSTRUCTION PROVIDED THAT THESE CAVITIES ARE FILLED WITH INSULATION.

² R402.2.1 CEILINGS WITH ATTIC SPACES.

WHEN SECTION R402.1.1 WOULD REQUIRE R-38 IN THE CEILING, INSTALLING R-30 OVER 100 PERCENT OF THE CEILING AREA REQUIRING INSULATION SHALL BE DEEMED TO SATISFY THE REQUIREMENT FOR R-38 WHEREVER THE FULL HEIGHT OF UNCOMPRESSED R-30 INSULATION EXTENDS OVER THE WALL TOP PLATE AT THE EAVES. SIMILARLY, R-38 SHALL BE DEEMED TO SATISFY THE REQUIREMENT FOR R-49 WHEREVER THE FULL HEIGHT OF UNCOMPRESSED R-38 INSULATION EXTENDS OVER THE WALL TOP PLATE AT THE EAVES. THIS REDUCTION SHALL NOT APPLY TO THE U-FACTOR ALTERNATIVE APPROACH IN SECTION R402.1.3 AND THE TOTAL UA ALTERNATIVE IN SECTION R402.1.4.


³ R402.2.2 CEILINGS WITHOUT ATTIC SPACES.


WHERE SECTION R402.1.1 WOULD REQUIRE INSULATION LEVELS ABOVE R-30 AND THE DESIGN OF THE ROOF/CEILING ASSEMBLY DOES NOT ALLOW SUFFICIENT SPACE FOR THE REQUIRED INSULATION, THE MINIMUM REQUIRED INSULATION FOR SUCH ROOF/CEILING ASSEMBLIES SHALL BE R-30. THIS REDUCTION OF INSULATION FROM THE REQUIREMENTS OF SECTION R402.1.1 SHALL BE LIMITED TO 500 SQUARE FEET (46 M2) OR 20 PERCENT OF THE TOTAL INSULATED CEILING AREA, WHICHEVER IS LESS. THIS REDUCTION SHALL NOT APPLY TO THE U-FACTOR ALTERNATIVE APPROACH IN SECTION R402.1.3 AND THE TOTAL UA ALTERNATIVE IN SECTION R402.1.4.

⁴ TABLE R402.1.2 BASEMENT R-VALUE

"15/19" MEANS R-15 CONTINUOUS INSULATION ON THE INTERIOR OR EXTERIOR OF THE HOME OR R-19 CAVITY INSULATION AT THE INTERIOR OF THE BASEMENT WALL. "15/19" SHALL BE PERMITTED TO BE MET WITH R-13 CAVITY INSULATION ON THE INTERIOR OF THE BASEMENT WALL PLUS R-5 CONTINUOUS INSULATION ON THE INTERIOR OR EXTERIOR OF THE HOME

G.C. TO VERIFY WITH CODE OFFICIAL TO CONFIRM ADDITIONAL ENERGY CODE COMPLIANCE REQUIREMENTS

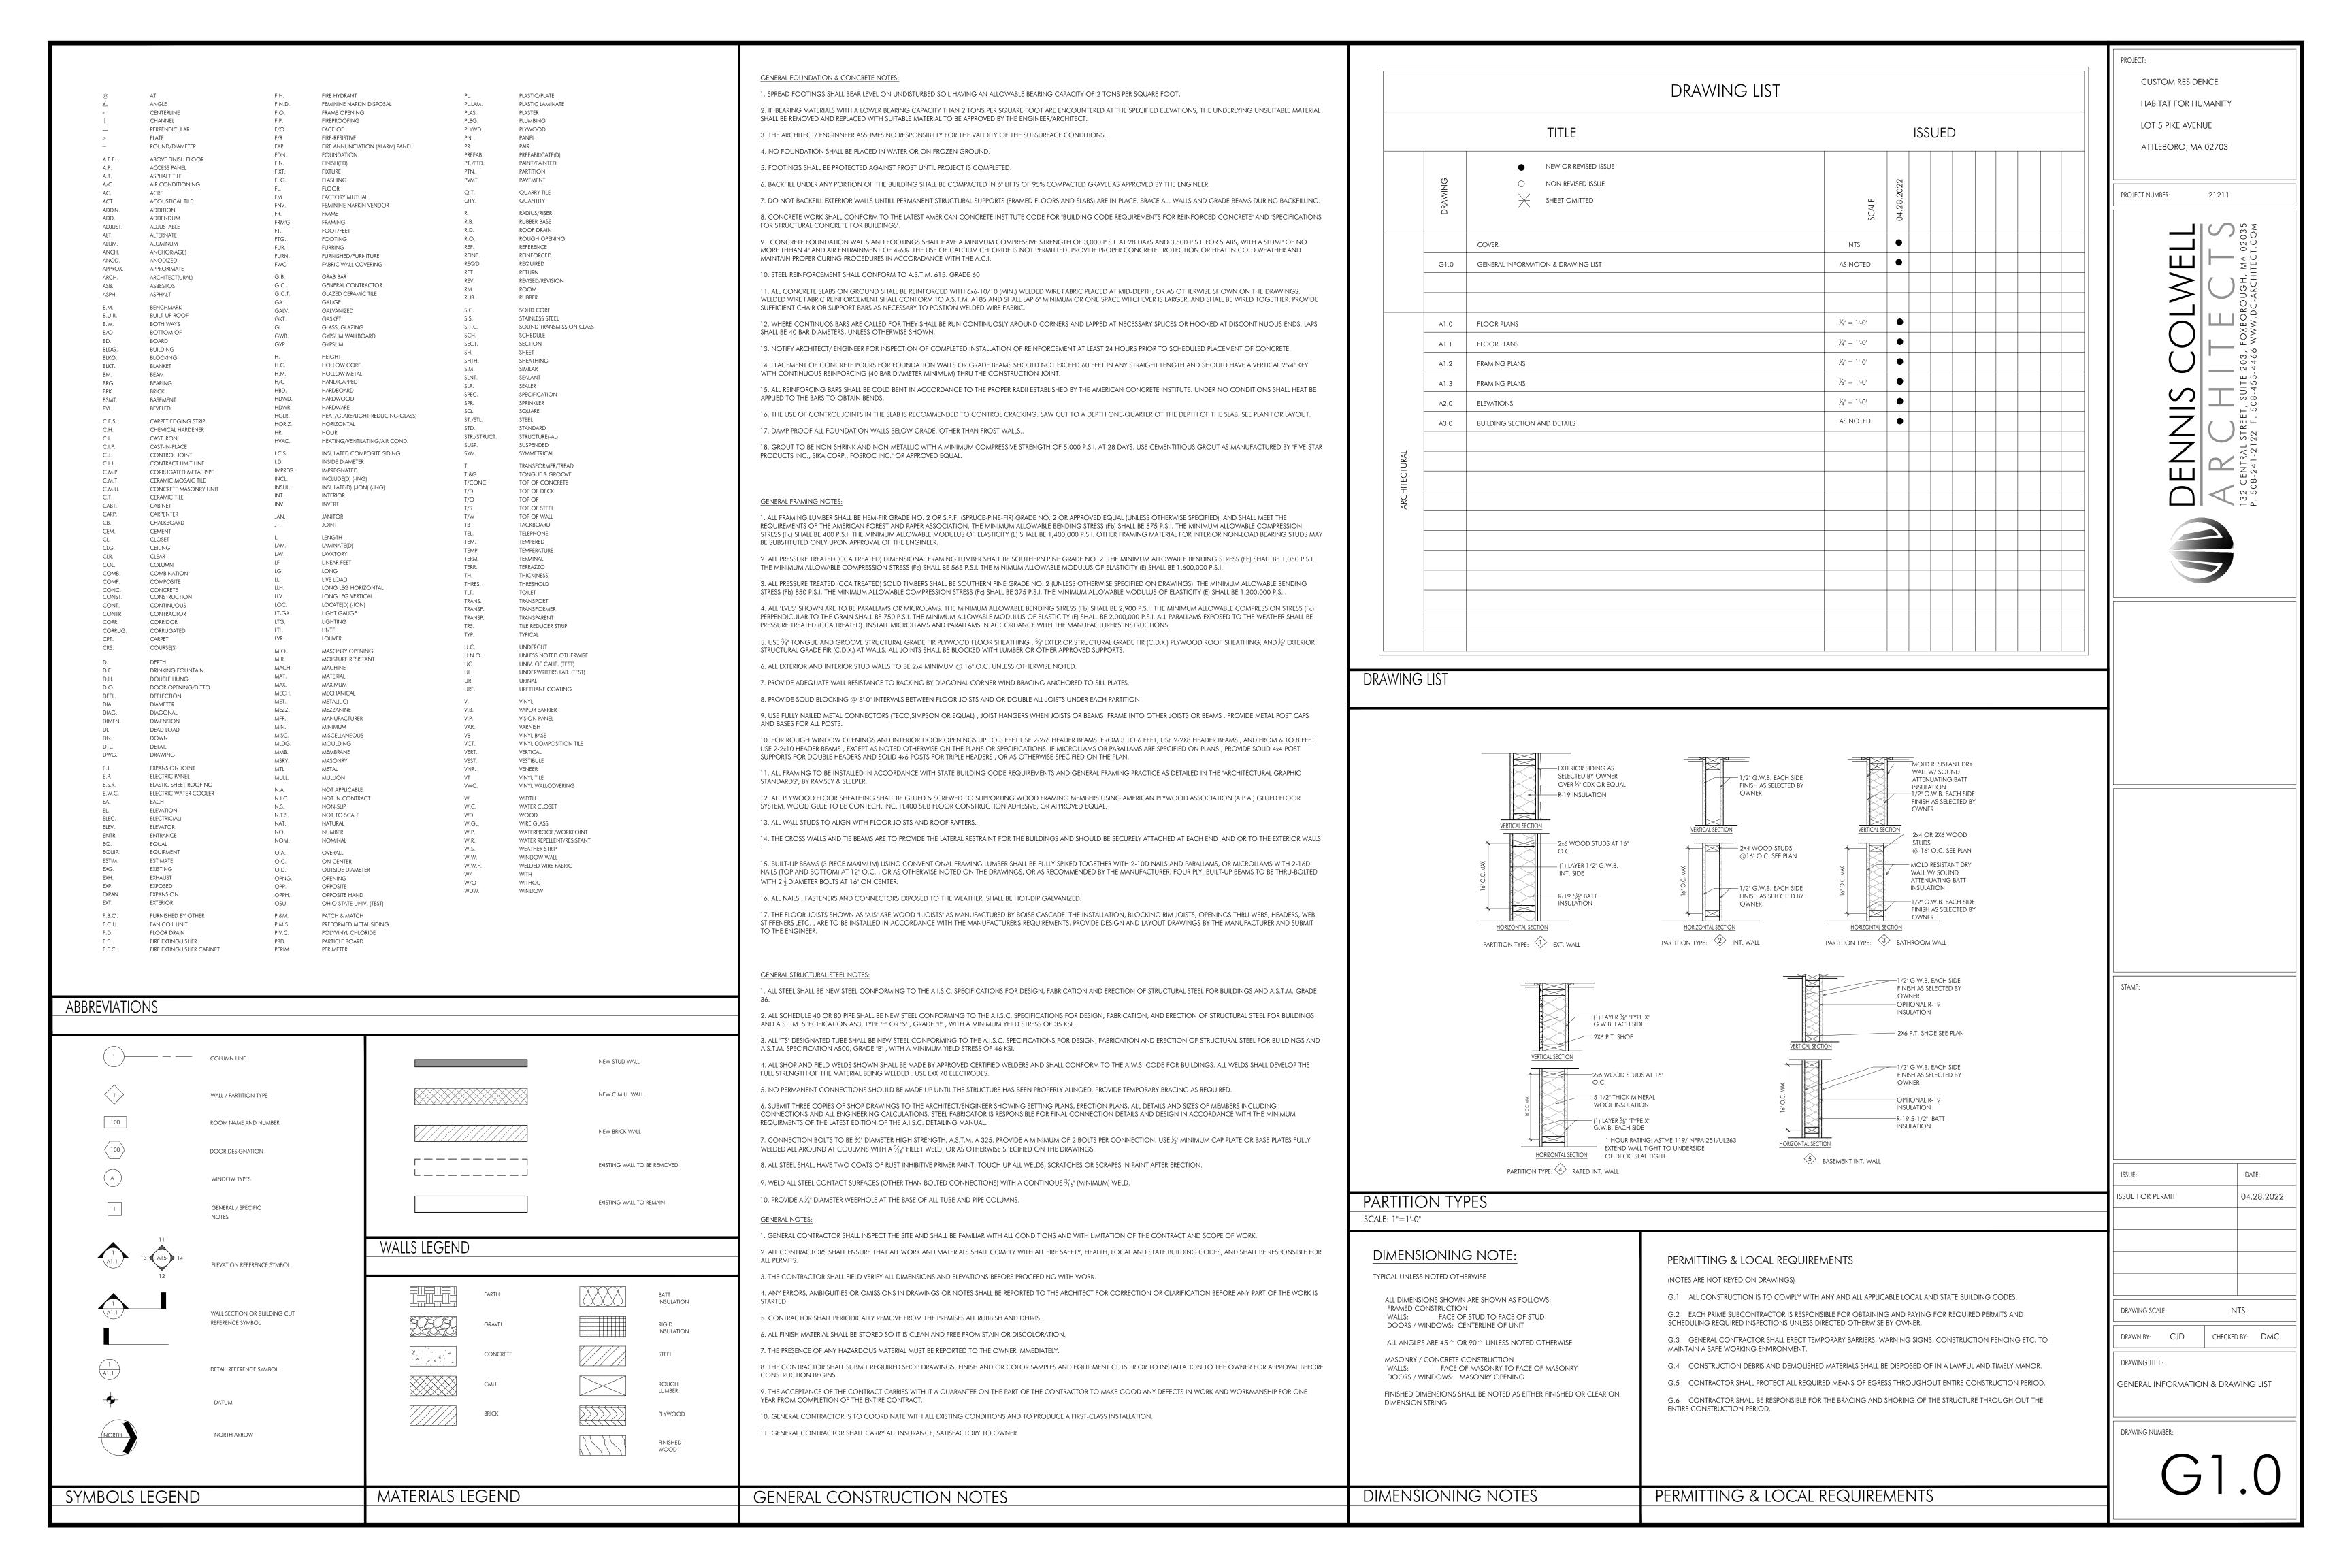

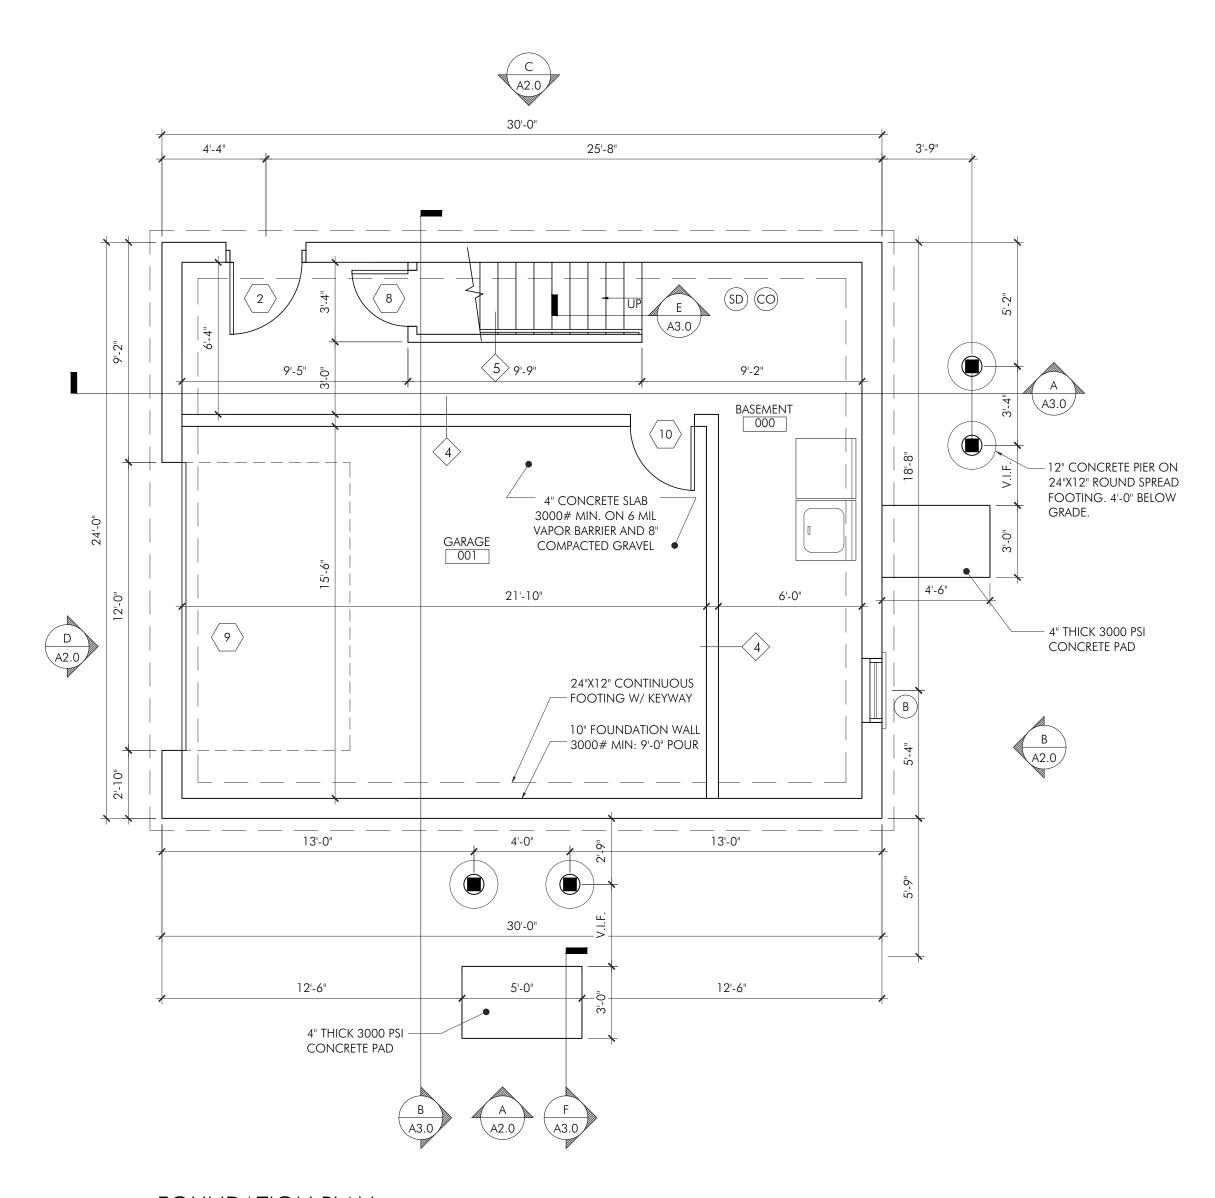

FOUNDATION PLAN SCALE: 1/4" = 1'-0"

CO CARBON MONOXIDE DETECTOR


SD SMOKE DETECTOR (PHOTO ELECTRIC)

(HD) 135 DEG RATE OF RISE HEAT DETECTOR

FL FAN LIGHT

	DOOR SCHEDULE							
I.D.	QT.*	DIMENSION	ROUGH OPEN'G*	MANUFACTERER	MATERIAL	DESCRIPTION	LOCATION	
1	1	3'-0"X6'-8"	AS VERIFIED BY G.C.	AS VERIFIED BY G.C.	THERMA-TRU	ENTRY	ENTRY	
2	1	3'-0"X6'-8"	AS VERIFIED BY G.C.	AS VERIFIED BY G.C.	THERMA-TRU	SIDE ENTRY	SIDE ENTRY	
3	4	2'-8"X6'-8"	AS VERIFIED BY G.C.	AS VERIFIED BY G.C.	WOOD	AS SELECTED BY G.C.	VARIOUS	
4	1	4'-0"X6'-8"	AS VERIFIED BY G.C.	AS VERIFIED BY G.C.	WOOD	BI-FOLD	CLOSET	
5	1	2'-6"X6'-8"	AS VERIFIED BY G.C.	AS VERIFIED BY G.C.	WOOD	SLIDER	BATHROOM	
6	3	4'-8"X6'-8"	AS VERIFIED BY G.C.	AS VERIFIED BY G.C.	WOOD	BI-FOLD	CLOSETS	
7	1	5'-0"X6'-8"	AS VERIFIED BY G.C.	AS VERIFIED BY G.C.	WOOD	AS SELECTED BY G.C.	CLOSET	
8	2	2'-6"X6'-8"	AS VERIFIED BY G.C.	AS VERIFIED BY G.C.	WOOD	AS SELECTED BY G.C.	STAIR	
9	1	12'-0"X7'-0"	AS VERIFIED BY G.C.	AS VERIFIED BY G.C.	STEEL	GARAGE ENTRY	GARAGE 001	
10	1	2'-8" X 6'-8"	AS VERIFIED BY G.C.	THERMA-TRU	*FIRE RATED*	AS SELECTED BY G.C.	BASEMENT 000	

*ALL QUANTITIES TO BE VERIFIED BY G.C. BEFORE ORDERING
*ALL ROUGH OPENINGS TO BE VERIFIED IN FIELD BEFORE ORDERING
*FIRE RATED DOOR B-LABEL 90 MINUTES

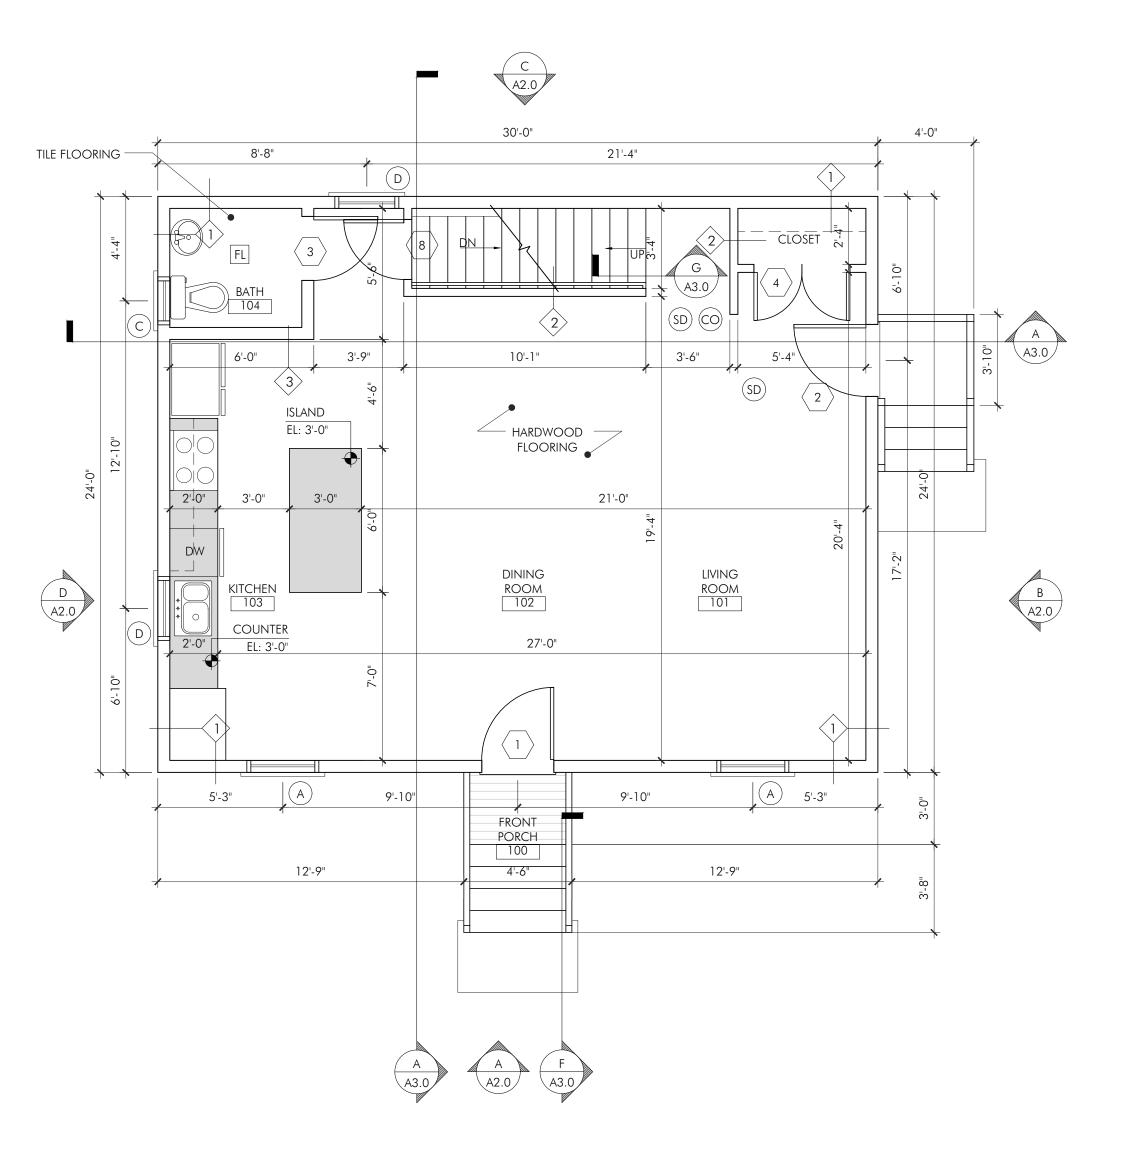

FIRST FLOOR PLAN SCALE: 1/4" = 1'-0"

CO CARBON MONOXIDE DETECTOR

SD SMOKE DETECTOR (PHOTO ELECTRIC)

(HD) 135 DEG RATE OF RISE HEAT DETECTOR

FL FAN LIGHT

	WINDOW SCHEDULE								
I.D.	QT.	MODEL#	ROUGH OPENING	MANUFACTURER	MATERIAL	DESCRIPTION	LOCATION	PATTERN	
А	8	AS SELECTED BY G.C.	3'-5 ½" X 4'-9 ½"	AS SELECTED BY G.C.	VINYL	DOUBLE HUNG	VARIOUS	12/12	
В	1	AS SELECTED BY G.C.	V.I.F	AS SELECTED BY G.C.	VINYL	HOPPER	BASEMENT	NONE	
С	1	AS SELECTED BY G.C.	3'-0 ½" X 3'-8 ½"	AS SELECTED BY G.C.	VINYL	DOUBLE HUNG	STAIR	8/8	
D	2	AS SELECTED BY G.C.	2'-4 ½" X 3'-8 ½"	AS SELECTED BY G.C.	VINYL	DOUBLE HUNG	VARIOUS	6/6	
Е	2	AS SELECTED BY G.C.	2'-0 ½" X 2'-0 ½"	AS SELECTED BY G.C.	VINYL	PICTURE	BATHROOM	9	

*ALL QUANTITIES TO BE VERIFIED BY G.C. BEFORE ORDERING
*ALL ROUGH OPENINGS TO BE VERIFIED IN FIELD BEFORE ORDERING

PROJECT:

CUSTOM RESIDENCE

HABITAT FOR HUMANITY

LOT 5 PIKE AVENUE

ATTLEBORO, MA 02703

DENNIS COLWELL

A R C H I T E C T S

132 CENTRAL STREET, SUITE 203, FOXBOROUGH, MA 02035
P. 508-241-2122 F. 508-455-4466 WWW.DC-ARCHITECT.COM

STAMP:

ISSUE:

DATE:

USSUE FOR PERMIT

D4.28.2022

DRAWING SCALE:

1/4" = 1'-0"

DRAWN BY:

CJD


CHECKED BY:

DMC

DRAWING TITLE:
FLOOR PLANS

DRAWING NUMBER:

A1.0

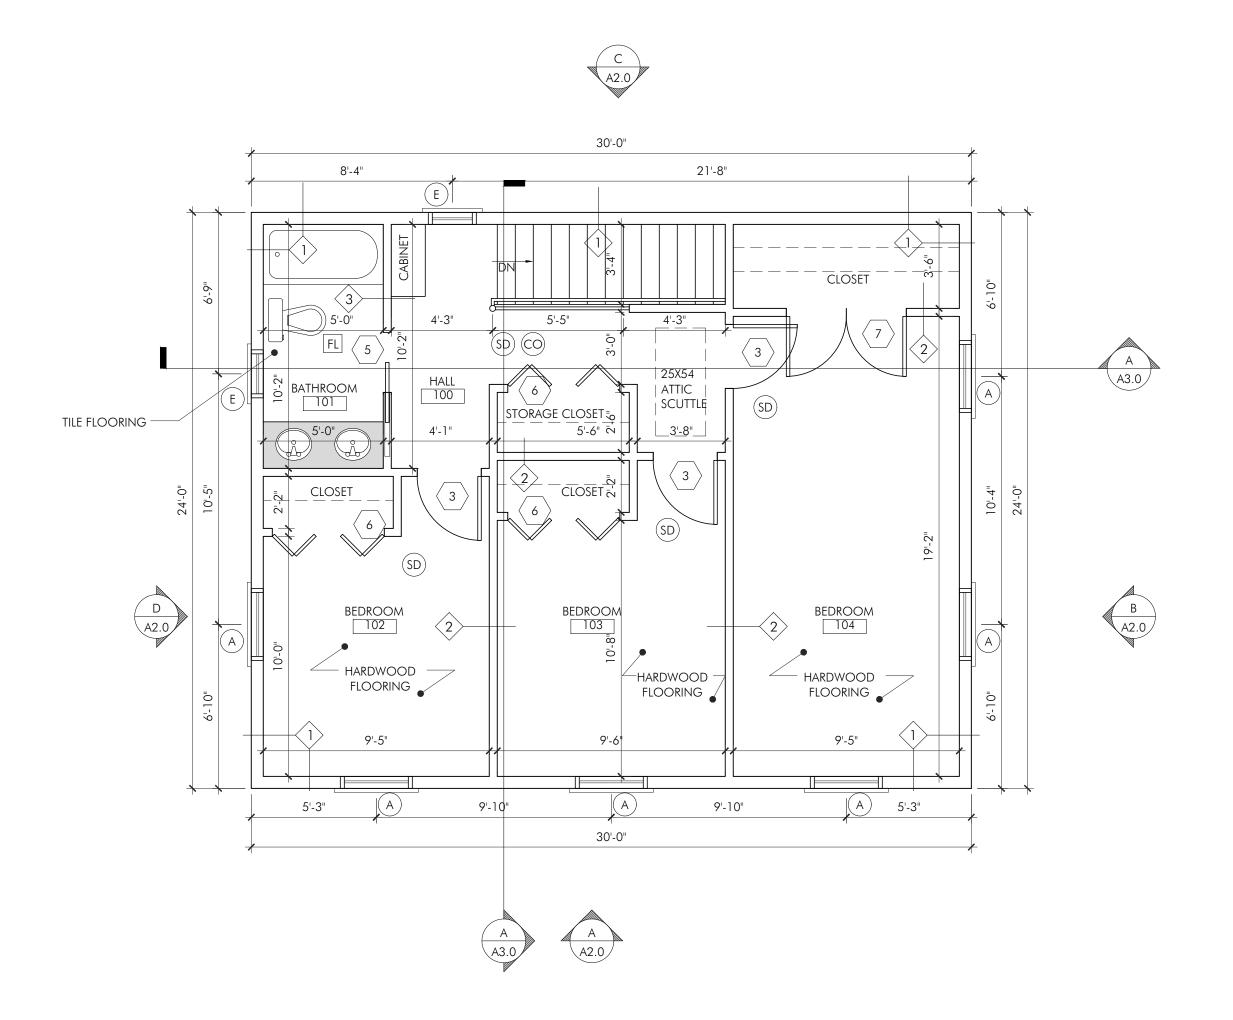

SECOND FLOOR PLAN SCALE: 1/4" = 1'-0"

SCALE: 1/4'' = 1'-0

CO CARBON MONOXIDE DETECTOR


SD) SMOKE DETECTOR (PHOTO ELECTRIC)

(HD) 135 DEG RATE OF RISE HEAT DETECTOR

FL FAN LIGHT

DOOR SCHEDULE							
I.D.	QT.*	DIMENSION	ROUGH OPEN'G*	MANUFACTERER	MATERIAL	DESCRIPTION	LOCATION
1	1	3'-0"X6'-8"	AS VERIFIED BY G.C.	AS VERIFIED BY G.C.	THERMA-TRU	ENTRY	ENTRY
2	1	3'-0"X6'-8"	AS VERIFIED BY G.C.	AS VERIFIED BY G.C.	THERMA-TRU	SIDE ENTRY	SIDE ENTRY
3	4	2'-8"X6'-8"	AS VERIFIED BY G.C.	AS VERIFIED BY G.C.	WOOD	AS SELECTED BY G.C.	VARIOUS
4	1	4'-0"X6'-8"	AS VERIFIED BY G.C.	AS VERIFIED BY G.C.	WOOD	BI-FOLD	CLOSET
5	1	2'-6"X6'-8"	AS VERIFIED BY G.C.	AS VERIFIED BY G.C.	WOOD	SLIDER	BATHROOM
6	3	4'-8"X6'-8"	AS VERIFIED BY G.C.	AS VERIFIED BY G.C.	WOOD	BI-FOLD	CLOSETS
7	1	5'-0"X6'-8"	AS VERIFIED BY G.C.	AS VERIFIED BY G.C.	WOOD	AS SELECTED BY G.C.	CLOSET
8	2	2'-6"X6'-8"	AS VERIFIED BY G.C.	AS VERIFIED BY G.C.	WOOD	AS SELECTED BY G.C.	STAIR
9	1	12'-0"X7'-0"	AS VERIFIED BY G.C.	AS VERIFIED BY G.C.	STEEL	GARAGE ENTRY	GARAGE 001
10	1	2'-8" X 6'-8"	AS VERIFIED BY G.C.	THERMA-TRU	*FIRE RATED*	AS SELECTED BY G.C.	BASEMENT 000

*ALL QUANTITIES TO BE VERIFIED BY G.C. BEFORE ORDERING
*ALL ROUGH OPENINGS TO BE VERIFIED IN FIELD BEFORE ORDERING
*FIRE RATED DOOR B-LABEL 90 MINUTES

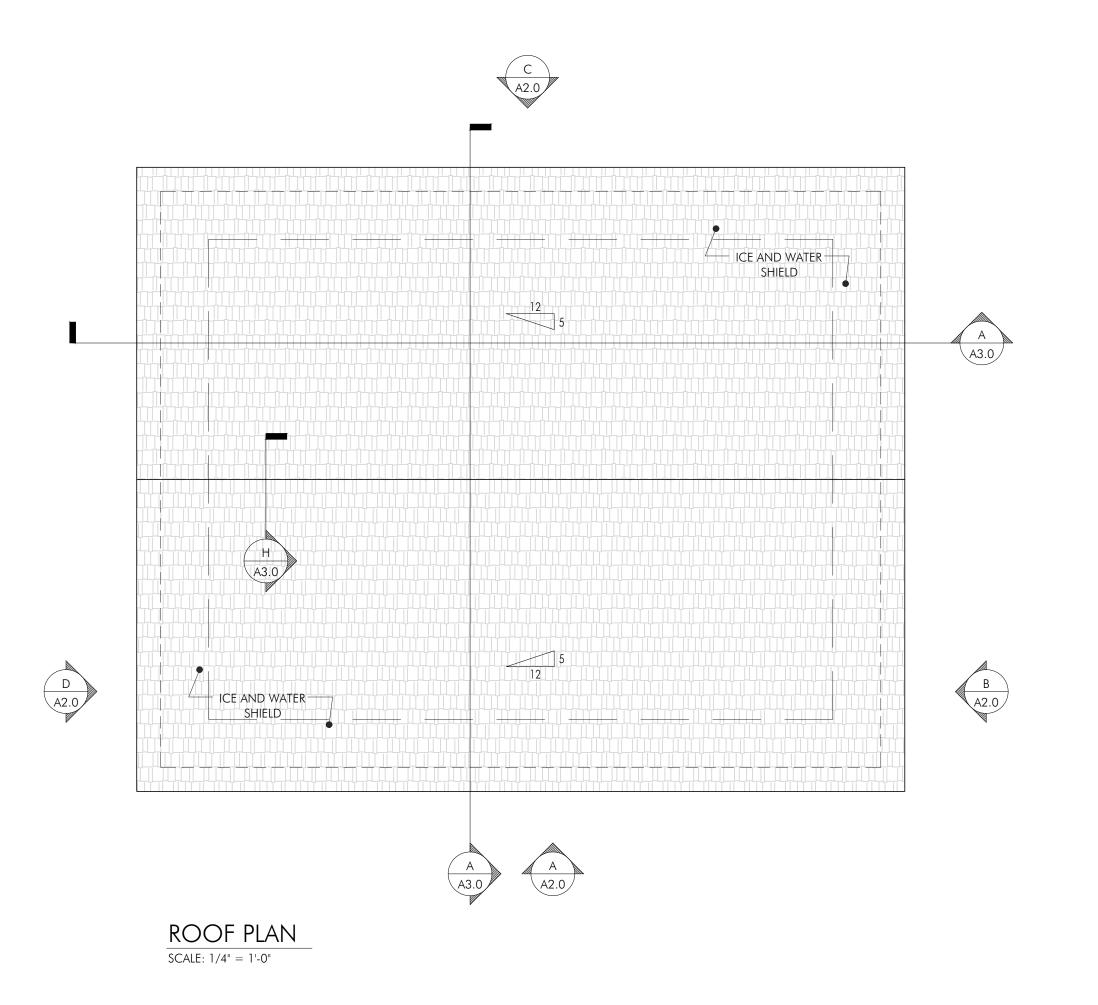

	WINDOW SCHEDULE								
I.D.	QT.	MODEL#	ROUGH OPENING	MANUFACTURER	MATERIAL	DESCRIPTION	LOCATION	PATTERN	
А	8	AS SELECTED BY G.C.	3'-5 ½" X 4'-9 ½"	AS SELECTED BY G.C.	VINYL	DOUBLE HUNG	VARIOUS	12/12	
В	1	AS SELECTED BY G.C.	V.I.F	AS SELECTED BY G.C.	VINYL	HOPPER	BASEMENT	NONE	
С	1	AS SELECTED BY G.C.	3'-0 ½" X 3'-8 ½"	AS SELECTED BY G.C.	VINYL	DOUBLE HUNG	STAIR	8/8	
D	2	AS SELECTED BY G.C.	2'-4 ½" X 3'-8 ½"	AS SELECTED BY G.C.	VINYL	DOUBLE HUNG	VARIOUS	6/6	
Е	2	AS SELECTED BY G.C.	2'-0 ½" X 2'-0 ½"	AS SELECTED BY G.C.	VINYL	PICTURE	BATHROOM	9	

*ALL QUANTITIES TO BE VERIFIED BY G.C. BEFORE ORDERING
*ALL ROUGH OPENINGS TO BE VERIFIED IN FIELD BEFORE ORDERING

CUSTOM RESIDENCE

HABITAT FOR HUMANITY

LOT 5 PIKE AVENUE

ATTLEBORO, MA 02703

PROJECT NUMBER: 21211

DENNIS COLWELL

A R C H I T E C T S

13.2 CENTRAL STREET, SUITE 203, FOXBOROUGH, MA 02035
P. 508-241-2122 F. 508-455-4466 WWW.DC-ARCHITECT.COM



DRAWING SCALE: 1/4" = 1'-0"


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FLOOR PLANS

DRAWING NUMBER:

DRAWING TITLE:

A1.1

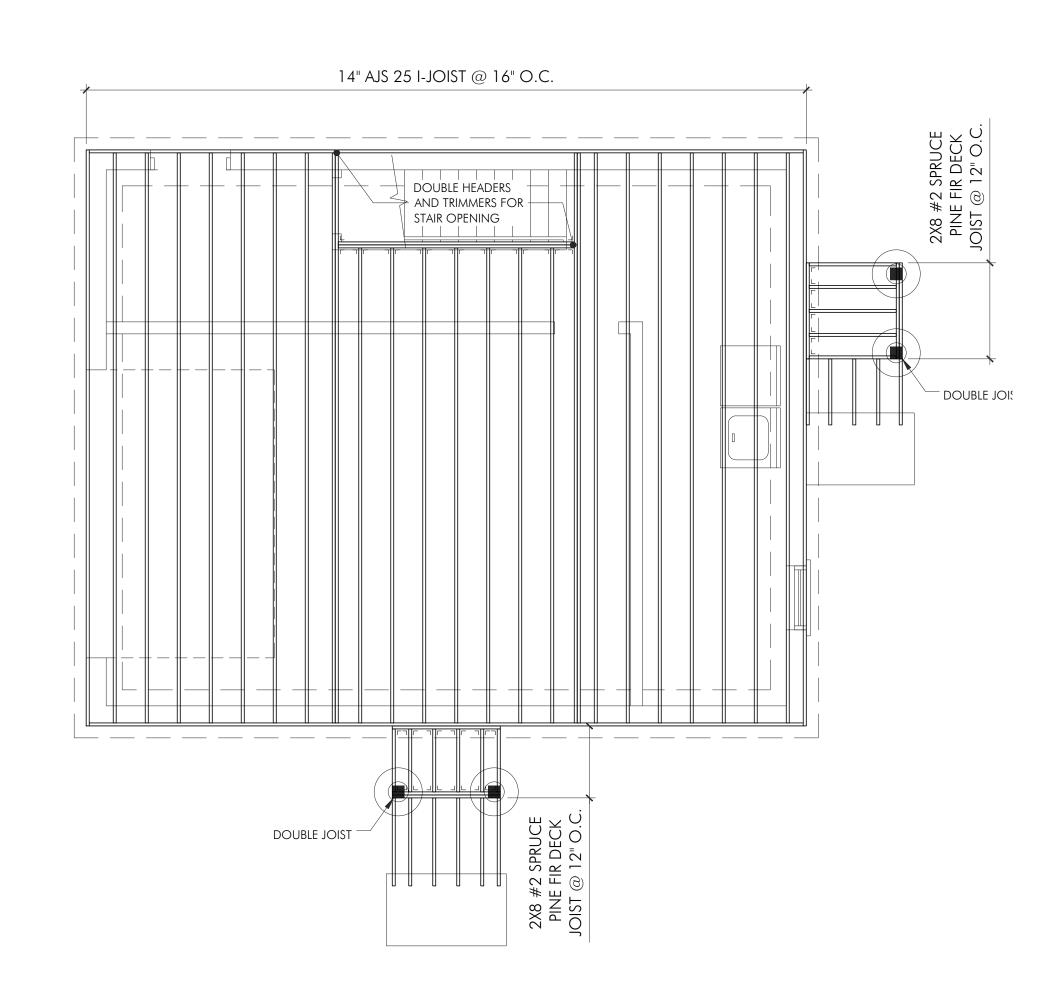


FIRST FLOOR FRAMING PLAN

SCALE: 1/4" = 1'-0"

FIRST FLOOR LOAD

UNLESS OTHERWISE NOTED DESIGN
LOADS: LIVE LOAD = 40 PSF

DEAD LOAD = 15 PSF

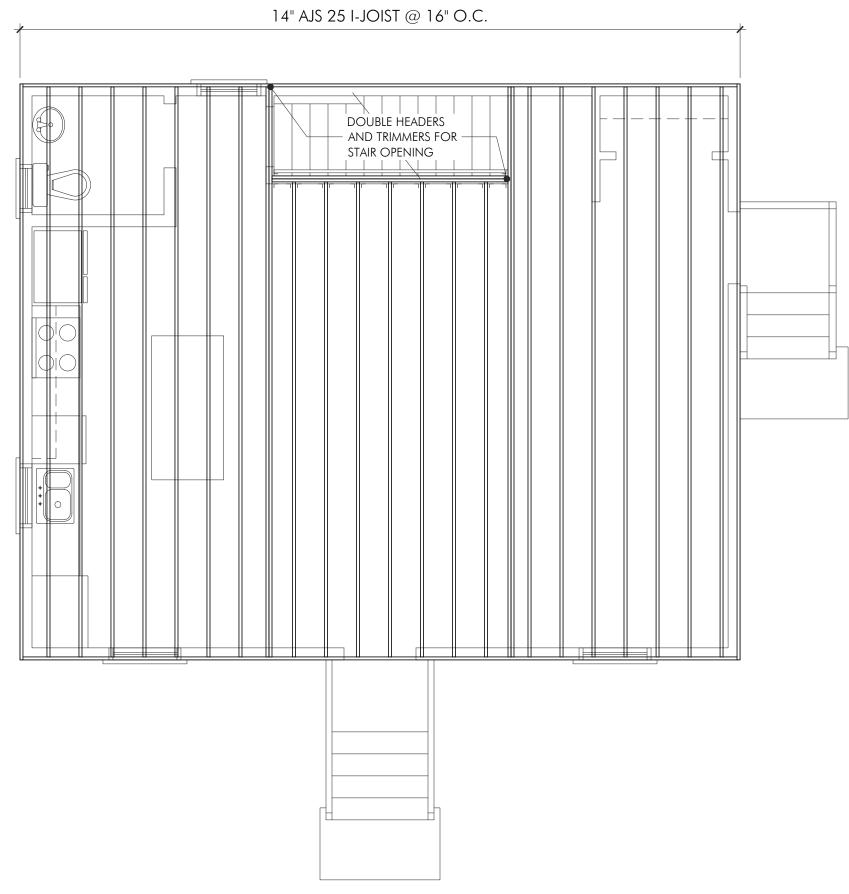

SECOND FLOOR FRAMING PLAN


SCALE: 1/4" = 1'-0"

SECOND FLOOR LOAD

UNLESS OTHERWISE NOTED DESIGN
LOADS: LIVE LOAD = 30 PSF
DEAD LOAD = 15 PSF

PROJECT: CUSTOM RESIDENCE HABITAT FOR HUMANITY LOT 5 PIKE AVENUE ATTLEBORO, MA 02703 PROJECT NUMBER: 21211 DATE: ISSUE FOR PERMIT 04.28.2022 1/4" = 1'-0" DRAWING SCALE: DRAWN BY: CJD CHECKED BY: DMC DRAWING TITLE: FRAMING PLANS


DRAWING NUMBER:

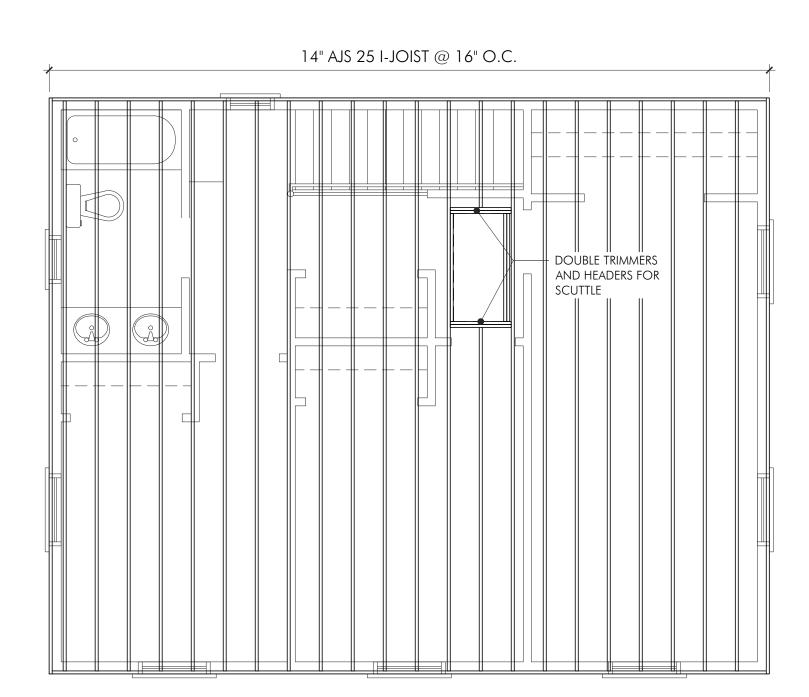

CEILING FRAMING PLAN

SCALE: 1/4" = 1'-0"

THIRD FLOOR LOAD
UNLESS OTHERWISE NOTED DESIGN
LOADS: LIVE LOAD = 20 PSF
DEAD LOAD = 10 PSF

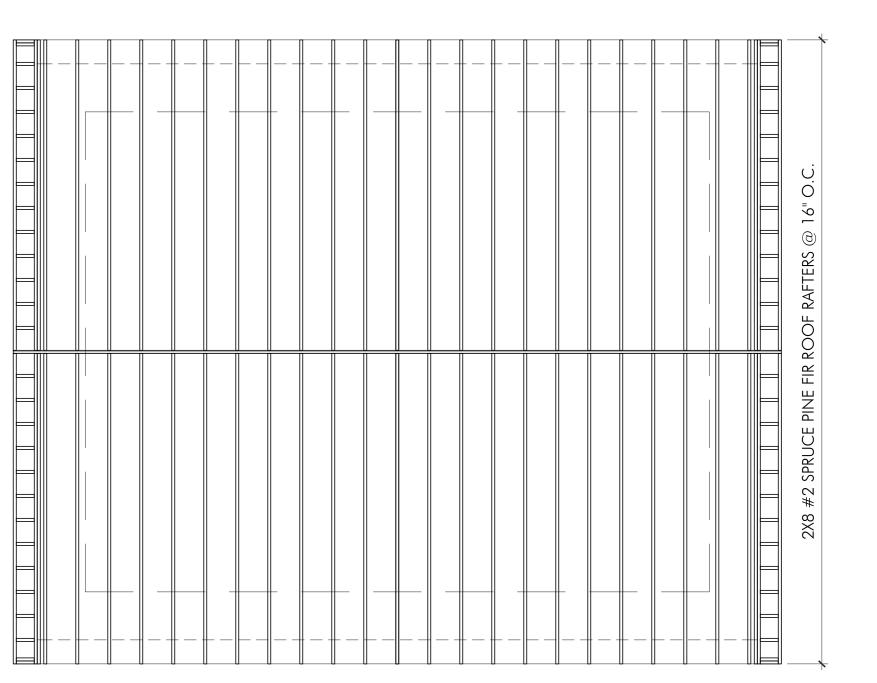

ROOF FRAMING PLAN

SCALE: 1/4" = 1'-0"

ROOF LOAD
UNLESS OTHERWISE NOTED DESIGN
LOADS: LIVE LOAD = 35 PSF
DEAD LOAD = 15 PSF

CUSTOM RESIDENCE HABITAT FOR HUMANITY LOT 5 PIKE AVENUE ATTLEBORO, MA 02703 PROJECT NUMBER: 21211 DENNIS STAMP: DATE: ISSUE FOR PERMIT 04.28.2022 1/4" = 1'-0" DRAWING SCALE: DRAWN BY: CJD CHECKED BY: DMC DRAWING TITLE:

FRAMING PLANS


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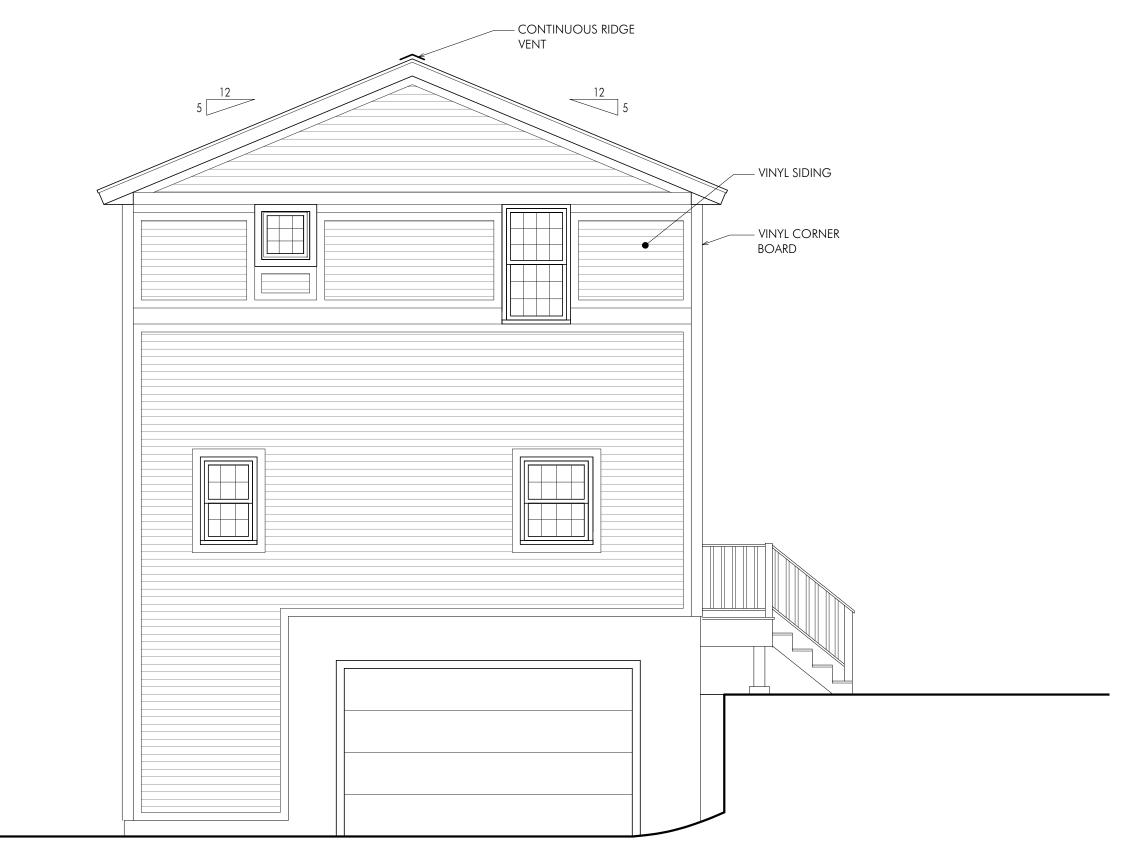
PROJECT:



REAR ELEVATION

SCALE: 1/4" = 1'-0"



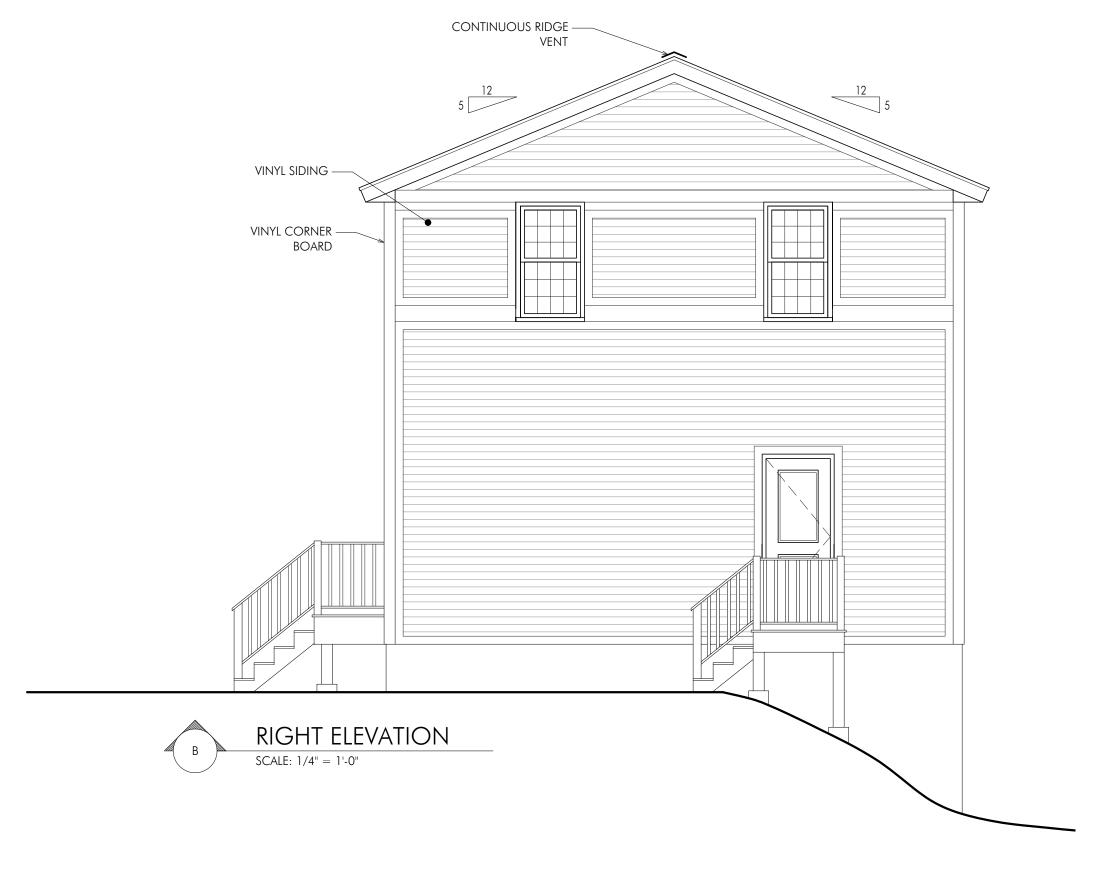



PROJECT:

CUSTOM RESIDENCE

HABITAT FOR HUMANITY

LOT 5 PIKE AVENUE

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CJD

CHECKED BY:

DRAWING TITLE:

DRAWING NUMBER:

ELEVATIONS

A2.0

